
LOCATION MAP NOT TO SCALE SITE

Approved Construction Plan

STORMWATER MANAGEMI	ENT PLAN
APPROVED	
CITY OF WILMINGTO	NC
ENGINEERING DEPART	MENT
DATE PERMIT #	
SIGNED	

For each open utility cut of City streets, a \$325 permit shall be required from the City prior to occupancy and/or project acceptance.

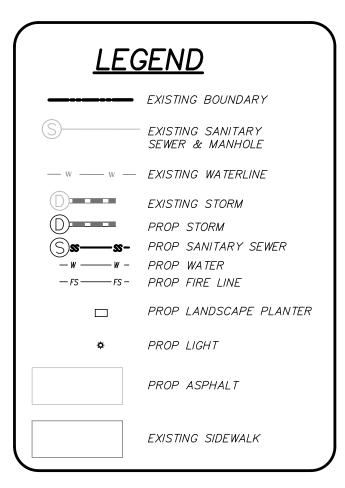




CONSTRUCTION DRAWINGS for

TR4 TFMPORARY PARKING 10T

UPPER DOWNTOWN FOOD & BEVERAGE COMPLEX

LOCATED IN CITY OF WILMINGTON NEW HANOVER COUNTY, NORTH CAROLINA

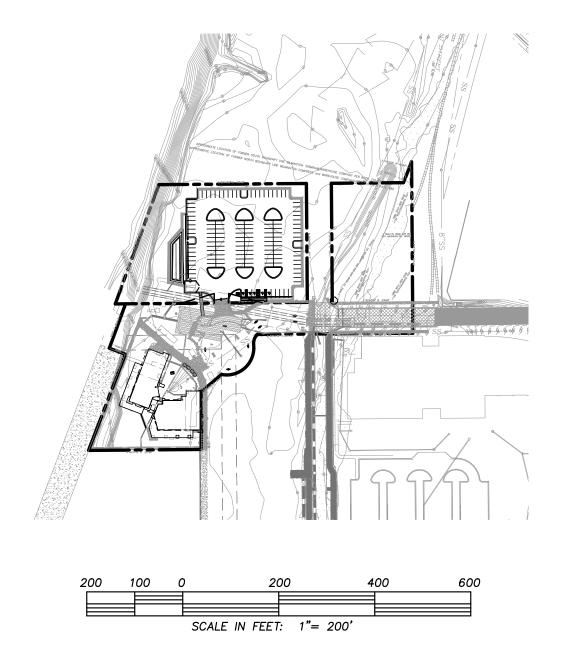

	INDEX TO DRAWINGS	
SHEET No.	DESCRIPTION	DRAWING No.
1 OF 5	COVER SHEET	cov
2 OF 5	SITE PLAN	SP1
3 OF 5	SITE DETAILS	SP2
4 OF 5	GRADING & STORMWATER	TR4 SANDFILTER
5 OF 5	LANDSCAPING PLAN	LP1
	•	

OWNER: RIVERFRONT HOLDINGS II LLC 720 NORTH 3RD ST. SUITE 301 WILMINGTON, NC 28401


NOTES:


- 1. BOUNDARY AND TOPOGRAPHIC (NAD 88) SURVEY PERFORMED BY HANOVER DESIGN SERVICES, PA 1123 FLORAL PARKWAY WILMINGTON NC 28403 910-343-8002, FIRM # C-0597
- 2. THIS MAP IS NOT FOR CONVEYANCE, RECORDATION, OR SALES.
- 3. THIS PROPERTY IS NOT LOCATED WITHIN A SPECIAL FLOOD HAZARD AREA ACCORDING TO FEMA MAPS.
- 4. THIS PROPERTY IS ZONED CBD
- 5. CFPUA WATER
- 6. CFPUA SEWER
- 7. ALL CONSTRUCTION TO CONFORM TO NEW HANOVER COUNTY STANDARDS AND APPLICABLE STATE & LOCAL CODES.
- 8. CONTRACTOR TO COORDINATE ANY REQUIRED TRAFFIC CONTROL WITH CITY OF WILMINGTON AND OR NCDOT.
- 9. CARE SHALL BE TAKEN DURING FINAL GRADING TO ENSURE POSITIVE DRAINAGE AWAY FROM BUILDINGS AND TO RECEIVING STRUCTURES. ROOF DRAIN DOWNSPOUTS TO BE CONNECTED TO STORM DRAINAGE STUBOUTS OR DIRECTED TO STREET/PARKING AREAS.
- 10. CONTRACTOR IS RESPONSIBLE FOR COORDINATION OF ANY RELOCATIONS, RE-ALIGNMENTS, DISCONNECTIONS OR CONNECTIONS OF EXISTING UTILITIES WITH APPLICABLE AUTHORITIES.
- 11. CLEARING AND GRUBBING OF SITE TO INCLUDE REMOVAL OF EXISTING CURB, ASPHALT, INLETS, AND ANY OTHER STRUCTURES INCLUDING TREES, STUMPS AND DEBRIS EXISTING ON SITE. TREES NOT REQUIRED TO BE CLEARED FOR CONSTRUCTION SHALL REMAIN UNLESS OTHERWISE DIRECTED
- 12. INFORMATION CONCERNING UNDERGROUND UTILITIES WAS OBTAINED FROM AVAILABLE RECORDS. IT SHALL BE THE RESPONSIBILITY OF THE CONTRACTOR TO DETERMINE THE EXACT ELEVATIONS AND LOCATIONS OF ALL EXISTING UTILITIES AT ALL CROSSINGS PRIOR TO COMMENCING TRENCH EXCAVATION. IF ACTUAL CLEARANCES ARE LESS THAN INDICATED ON PLAN, THE CONTRACTOR SHALL CONTACT THE DESIGN ENGINEER BEFORE PROCEEDING WITH CONSTRUCTION. ANY CONDITION DISCOVERED OR EXISTING THAT WOULD NECESSITATE A MODIFICATION OF THESE PLANS SHALL BE BROUGHT TO THE ATTENTION OF THE DESIGN ENGINEER BEFORE PROCEEDING
- 13. NO CONSTRUCTION IS TO BEGIN BEFORE LOCATION OF EXISTING UTILITIES HAS BEEN DETERMINED. CALL "NC ONE—CALL" AT LEAST
- 48 HOURS BEFORE COMMENCING CONSTRUCTION. 14. CONTRACTOR SHALL ADJUST ALL MANHOLES, VALVE & CURB BOXES TO FINAL GRADE UPON COMPLETION OF ALL CONSTRUCTION. ANY BOXES DAMAGED OR OTHERWISE DISTURBED BY THE CONTRACTOR SHALL BE REPAIRED AT THE EXPENSE OF THE CONTRACTOR.
- 15. THE CONTRACTOR IS RESPONSIBLE FOR CONTROLLING DUST AND EROSION DURING CONSTRUCTION AT HIS EXPENSE. PARKING AREAS SHALL BE
- WATERED TO CONTROL DUST WHEN ORDERED BY THE ENGINEER. 16. NO GEOTECHNICAL TESTING HAS BEEN PERFORMED ON SITE. NO WARRANTY IS MADE FOR SUITABILITY OF SUBGRADE, AND UNDERCUT AND ANY REQUIRED REPLACEMENT WITH SUITABLE MATERIAL SHALL BE THE RESPONSIBILITY OF THE CONTRACTOR.
- 17. EXTREME CARE SHALL BE TAKEN TO ENSURE MINIMUM SEPARATIONS AT ALL UTILITY CROSSING.
- 18. CONTRACTOR TO ENSURE THAT PAVEMENT IS PLACED SO AS TO DRAIN POSITIVELY TO THE STREET INLETS AND CATCH BASINS. ALL FUTURE ROOF DRAIN DOWNSPOUTS TO BE DIRECTED TO THE STORM DRAINAGE STUBOUTS.
- 19. CONTRACTOR IS RESPONSIBLE FOR OBTAINING ALL REQUIRED PERMITS.
- 20. THIS PLAN IS FOR SITE GRADING, UTILITIES, SITING, AND DRAINAGE ONLY. SEE BUILDING PLANS FOR DETAILED HOOKUPS TO BUILDINGS, ETC.
- 21. CONTRACTOR AND BUILDER ARE RESPONSIBLE FOR COORDINATING FINISHED FLOOR ELEVATION OF ALL BUILDINGS WITH THE OWNER. ELEVATIONS GIVEN ARE MINIMUM GROUND ELEVATIONS AT THE BUILDING SITE AND DO NOT PURPORT TO BE FINISHED FLOOR. MINIMUM RECOMMENDED FF ELEVATIONS
- 22. AFFECTED NON-MUNICIPAL UTILITIES SHALL BE CONTACTED AND PROVIDED WITH PLANS AND OTHER PERTINENT INFORMATION, WHEN FEASIBLE, TO COORDINATE APPROPRIATE SCHEDULING AND PLACEMENT.
- 23. MINIMUM SEPARATION SHALL BE MAINTAINED AS FOLLOWS: a. HORIZONTAL CLEARANCE OF 10 FEET BETWEEN SANITARY SEWER AND
- b. WHERE VERTICAL CLEARANCE IS LESS THAN 24" BETWEEN SANITARY SEWER AND WATER OR WHERE SEWER LINE CROSSES ABOVE WATER MAIN, BOTH PIPES SHALL BE DUCTILE IRON PIPE FOR A MINIMUM OF 10' EITHER SIDE OF CROSSING.
- c. WHERE VERTICAL CLEARANCE IS LESS THAN 24" BETWEEN SANITARY SEWER AND STORM DRAIN, SANITARY SEWER SHALL BE DUCTILE IRON PIPE FOR A MINIMUM OF 10' EITHER SIDE OF CROSSING.
- d. WHERE VERTICAL CLEARANCE IS LESS THAN 24" BETWEEN WATER MAIN AND STORM DRAIN, WATER MAIN SHALL BE DUCTILE IRON PIPE FOR A MINIMUM OF 10' EITHER SIDE OF CROSSING.
- 24. SEE DETAIL SHEETS FOR TYPICAL UTILITIES HOOKUPS.
- 25. ALL SANITARY SEWER MAINS TO BE 8" UNLESS OTHERWISE INDICATED.
- 26. ALL WATER MAINS TO BE 8" UNLESS OTHERWISE INDICATED.
- 27. TWO VALVES ARE REQUIRED AT "T" INTERSECTIONS AND ONE VALVE ON THE WATER LINE TO FIRE HYDRANTS.
- 28. A BLOW-OFF VALVE IS REQUIRED AT THE TERMINUS OF ALL "DEAD END"
- 29. ALL STRUCTURES TO MEET MINIMUM NCDOT TRAFFIC RATED SPECIFICATIONS.

COASTAI SITE DESIGN, PC

> LAND PLANNING COMMERCIAL / RESIDENTIAL P.O. Box 4041

Wilmington, NC 28406 (910) 791-4441

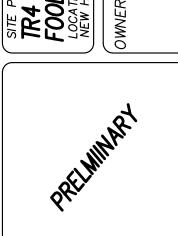

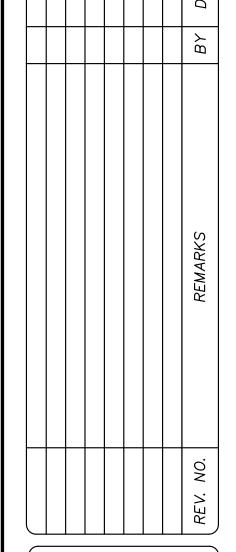


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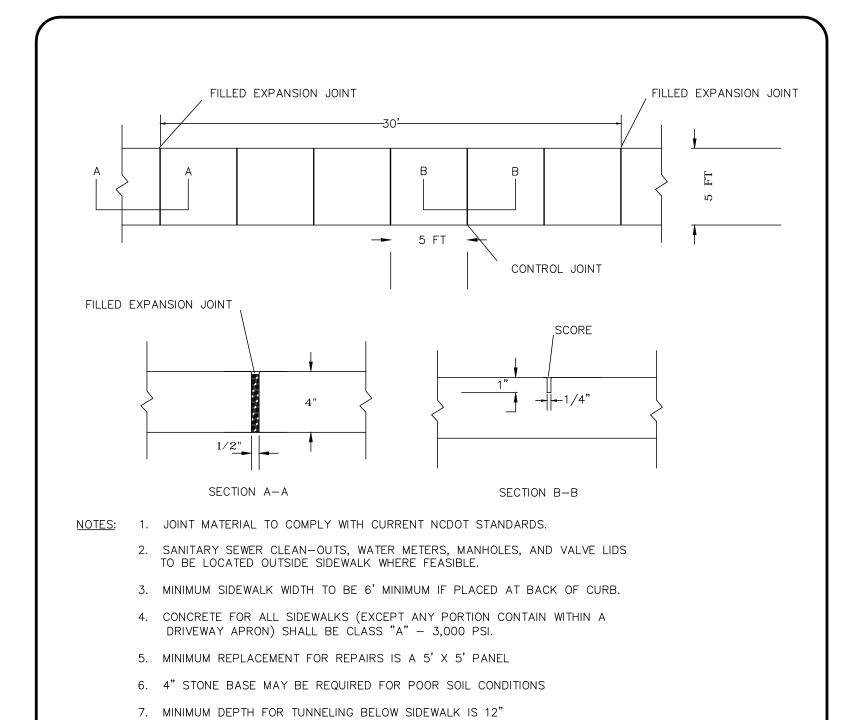
HORZ. SCALE: 1" = 200' VERT. SCALE: N/A

DRAWN BY: JSM CHECKED BY: HSR

PROJECT NO.: 07-0152

Sheet No. ______ Of _____



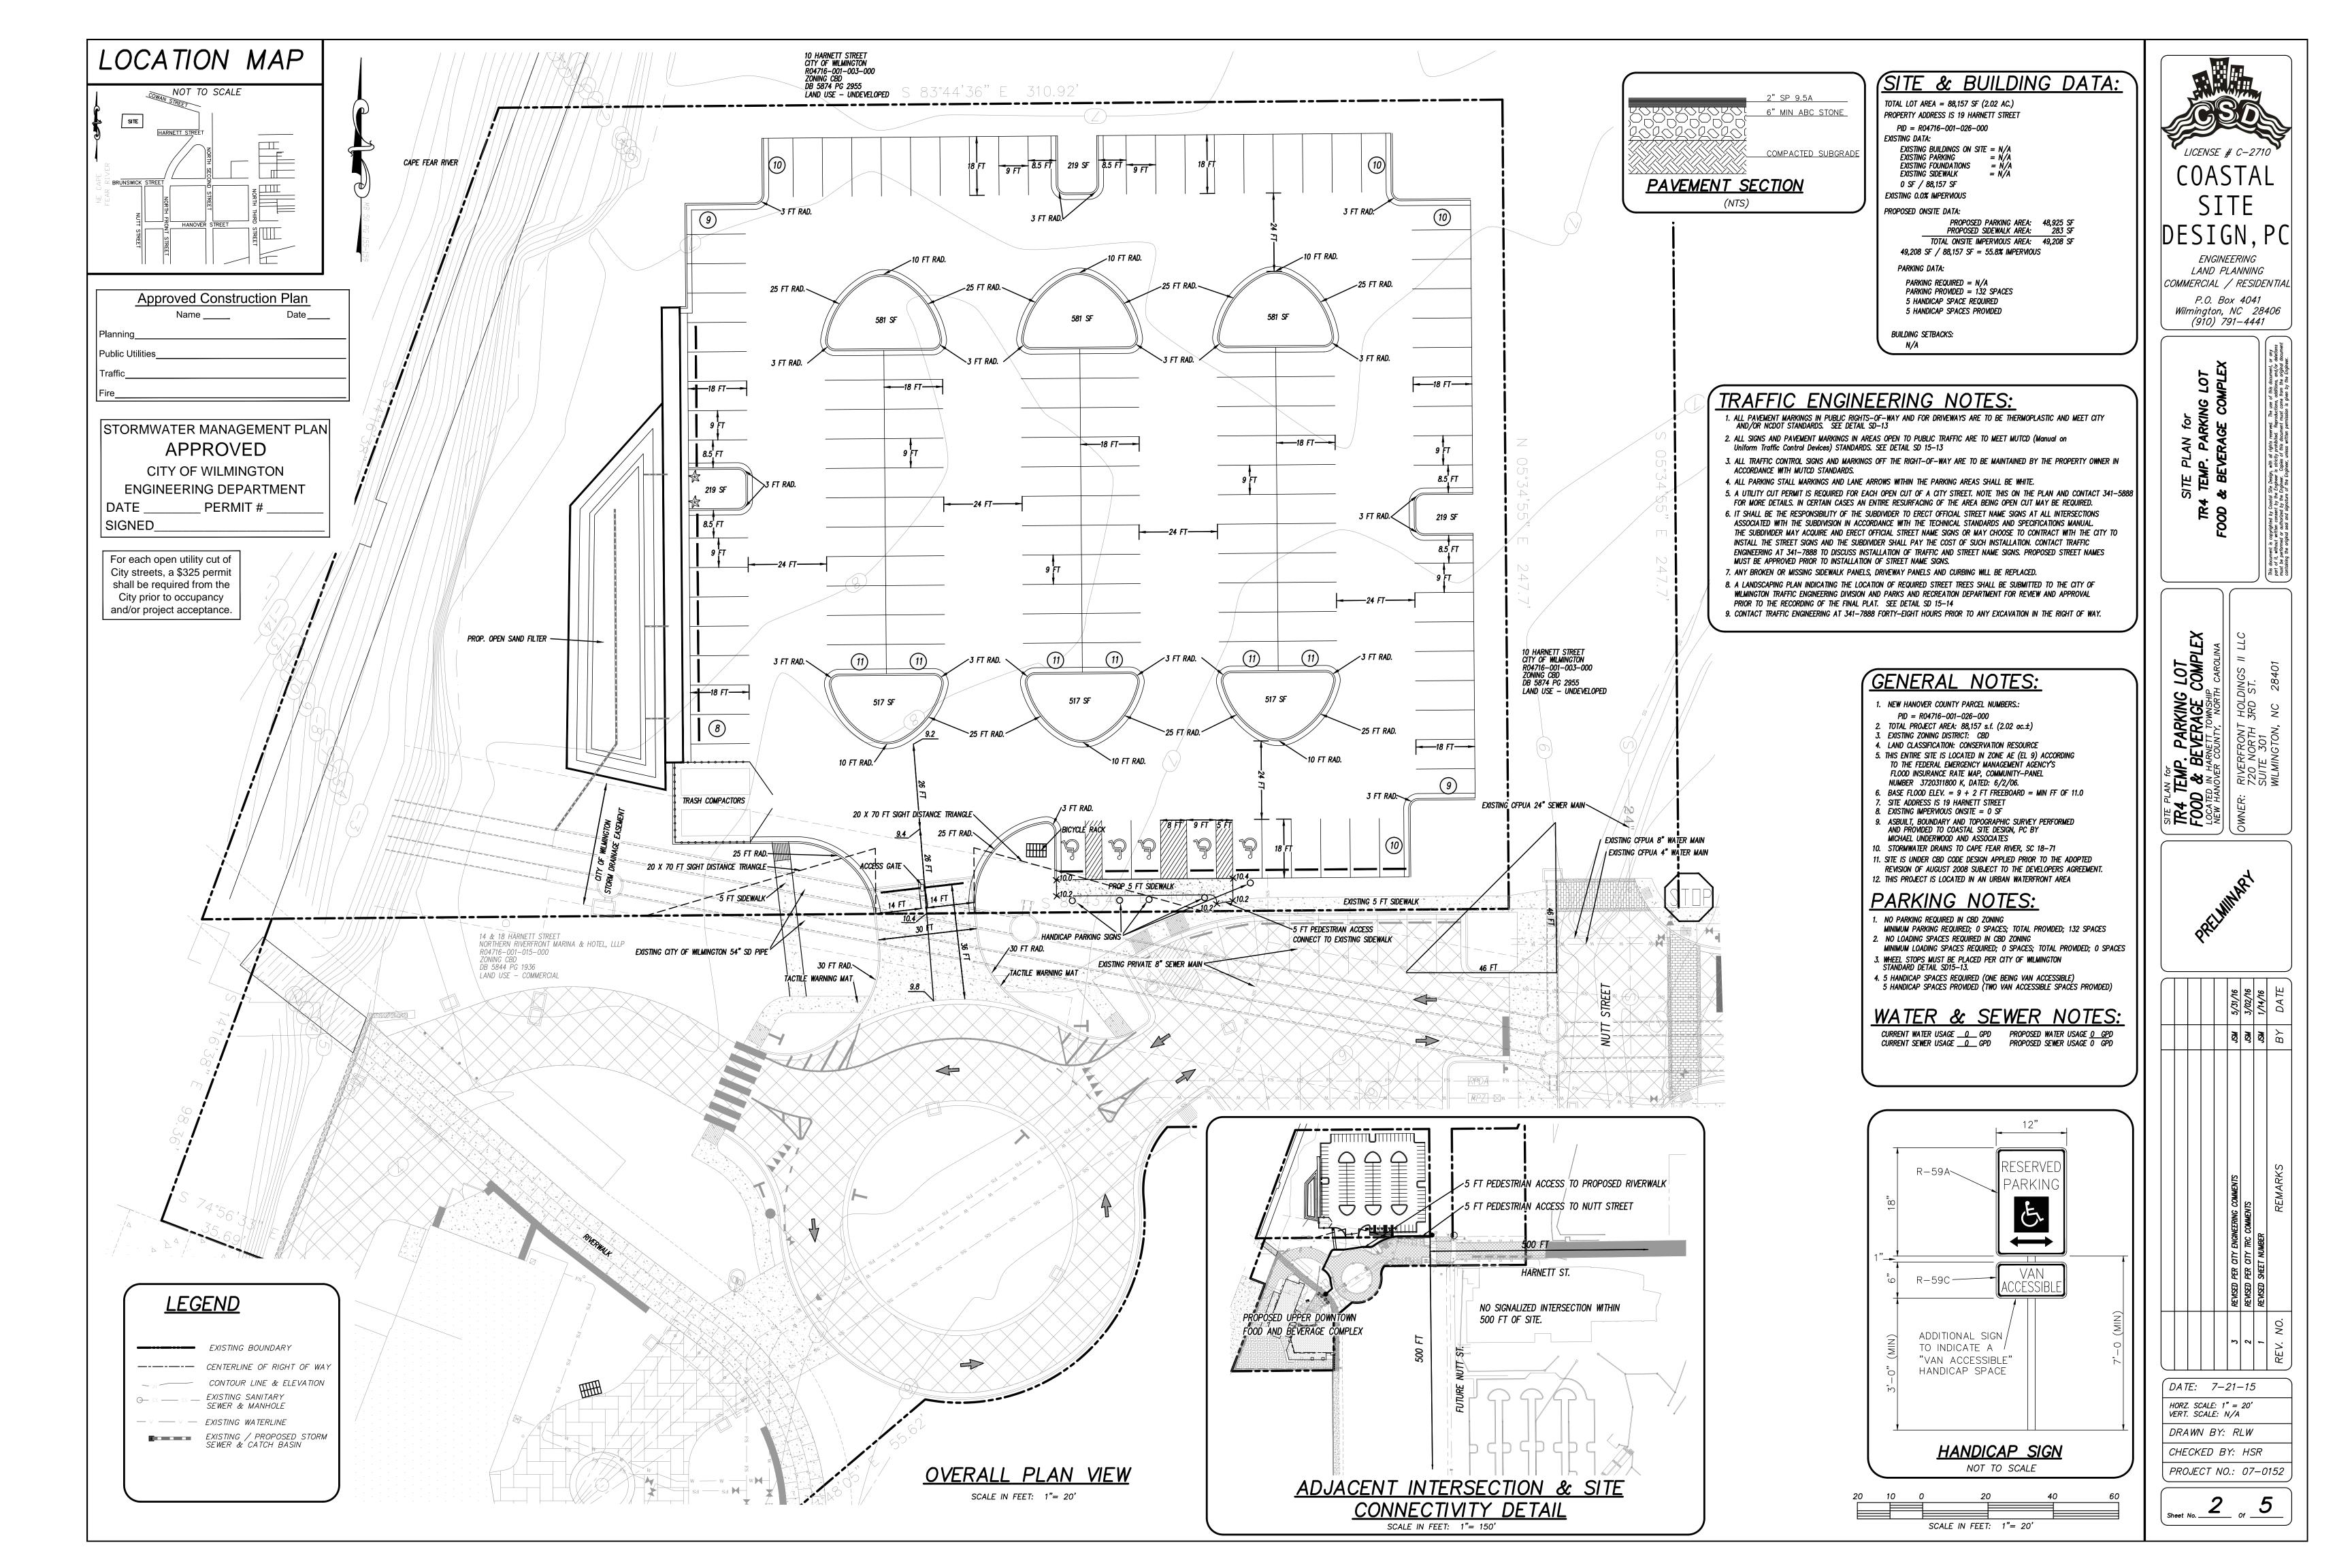

9. MIN GRADE FOR PROPER DRAINAGE IS 1% IN AT LEAST 1 DIRECTION. MAX CROSS SLOPE IS 2%.

STANDARD SIDEWALK DETAIL


SD 3-10


NTS


MAX LONGITUDINAL SLOPE IS 8.3%, 10% IF LIMITED BY EXISTING CONDITIONS, OR NO GREATER THAN

8. MAX ADJACENT GROUND SLOPE WITHOUT RAILING IS 2:1

THE SLOPE OF THE EXISTING ADJACENT ROAD.

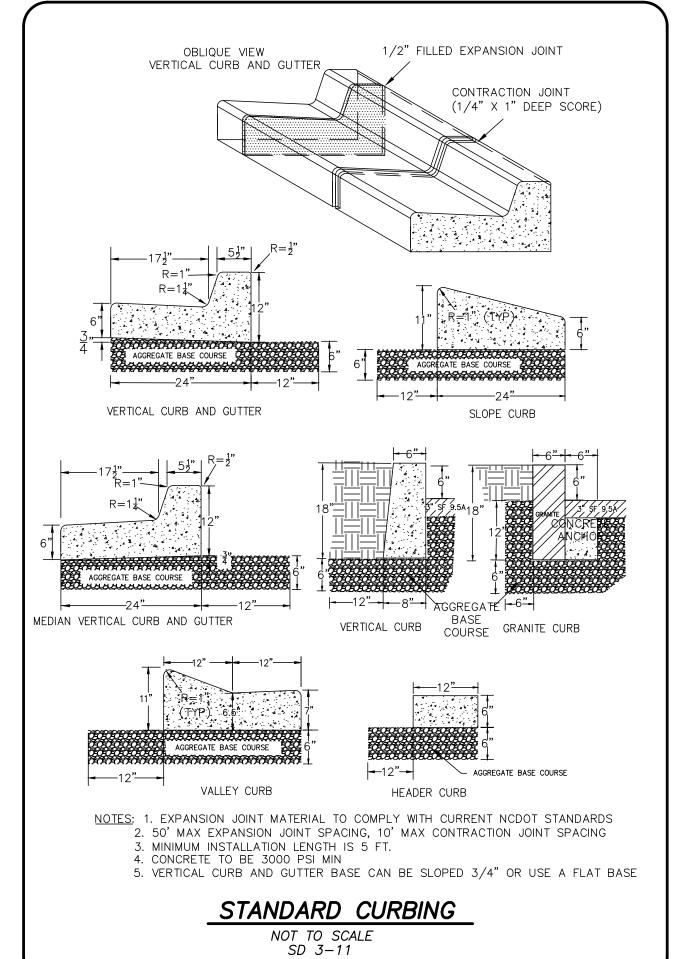

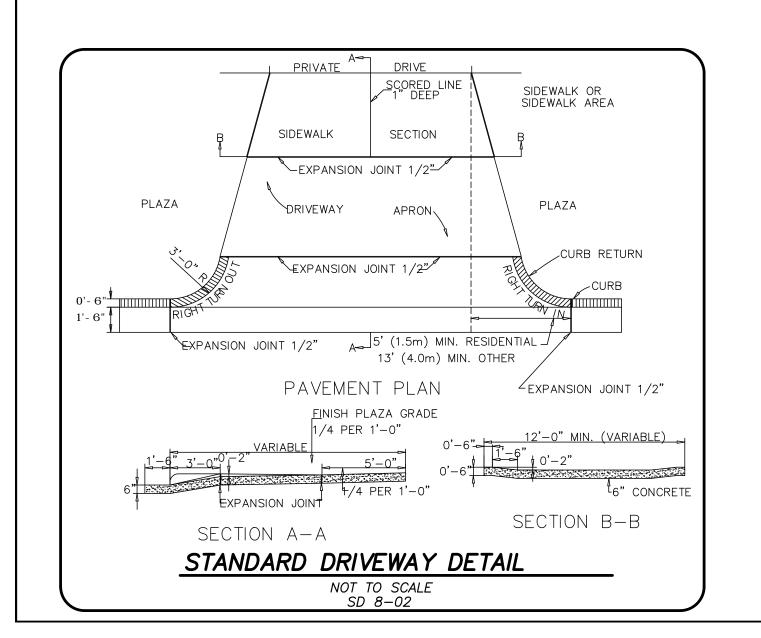

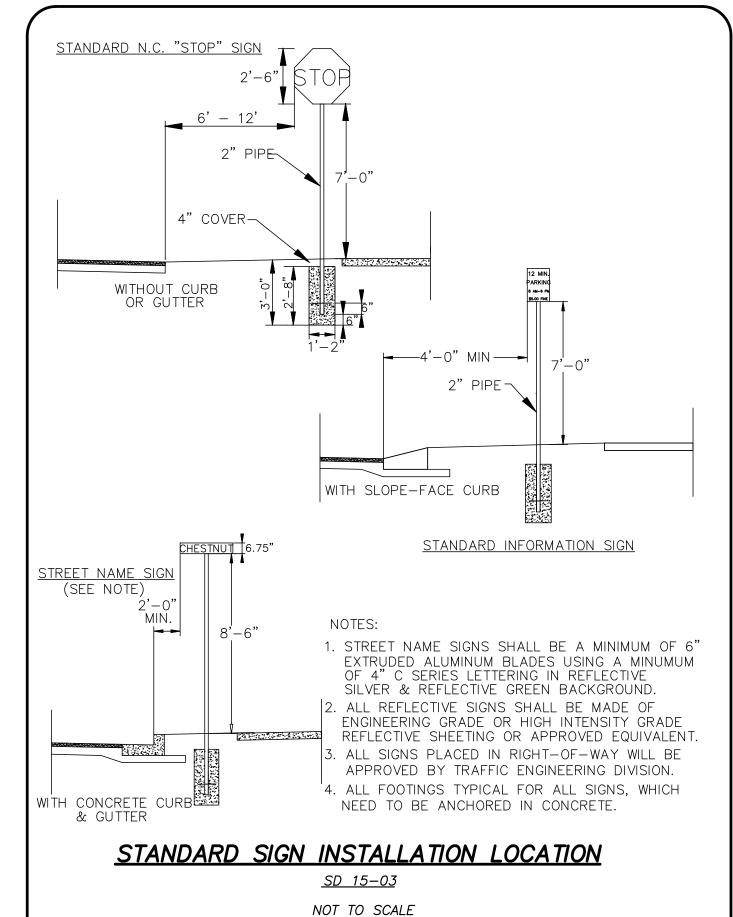

SITE DESIGN, PARKING LOT

SITE DESIGN, PARKING LOT

ENGINEERING
LAND PLANNING
COMMERCIAL / RESIDENTIAL

FOOD & BEVERAGE COMPLEX

BEVERAGE COMPLEX

1. William of a limited to be Engineer to the Engineer Codes of the adjoint document of the codinor and informer of the codinor and the profiles of the adjoint document of the codinor and the profiles of the adjoint document of the codinor and the profiles of the Engineer, codes of the document of the profiles of the Engineer, codes of the Engineer.

TR4 TEMP. PARKING LOT
FOOD & BEVERAGE COMPLEX
LOCATED IN HARNETT TOWNSHIP
NEW HANOVER COUNTY, NORTH CAROLINA
OWNER: RIVERFRONT HOLDINGS II LLC
720 NORTH 3RD ST.
SUITE 301
WILMINGTON, NC 28401



						MSr	MSr	ΑВ	
						REVISED PER CITY TRC COMMENTS	REVISED SHEET NUMBER	REMARKS	
						2	1	REV. NO.	
DATE: 9-05-12									

HORZ. SCALE: AS SHOWN VERT. SCALE: N/A

DRAWN BY: RLW

CHECKED BY: HSR

PROJECT NO.: 07-0152

For each open utility cut of City streets, a \$325 permit shall be required from the City prior to occupancy and/or project acceptance.


and of project acceptance.	╛				
	_				
Approved Construction Plan					
Name Date					
Planning					
Public Utilities					
Traffic					
Fire					

STORMWATER MANAGEMENT PLAN
APPROVED
CITY OF WILMINGTON

ENGINEERING DEPARTMENT
DATE _____ PERMIT # _____
SIGNED____

PARTMENT

//IT # _____ Sheet No. ______

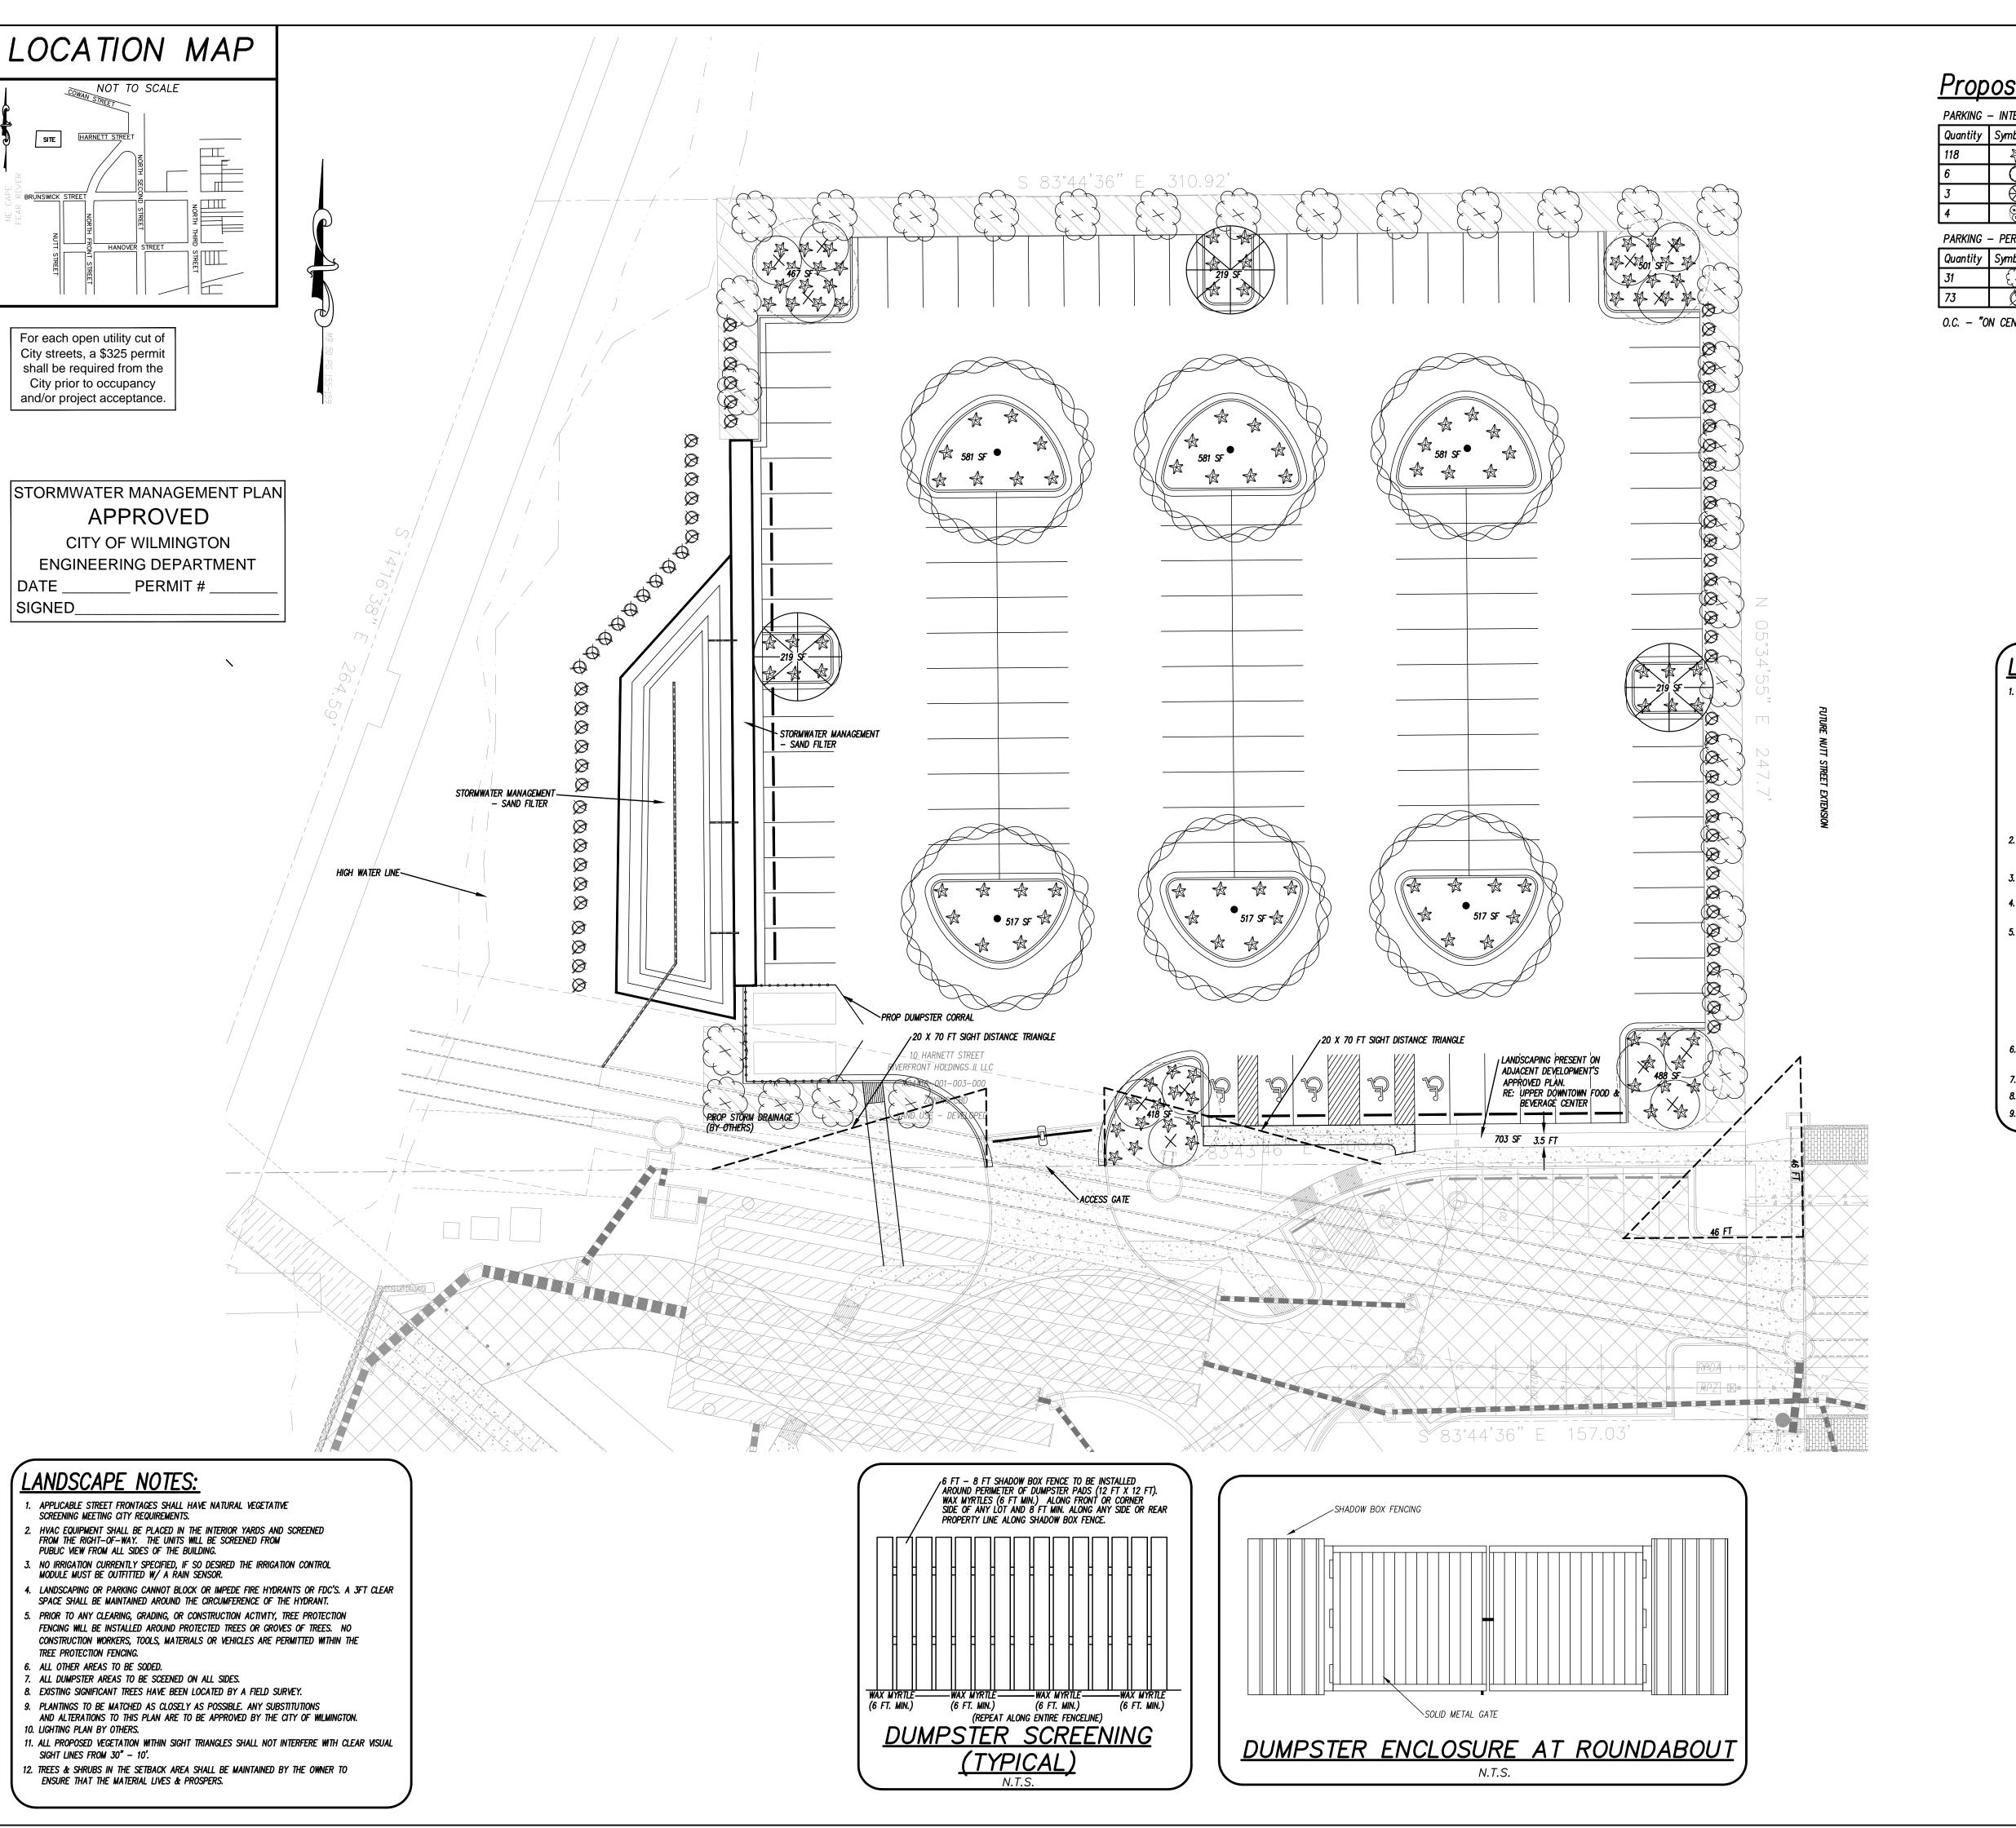

Proposed Plant Table

PARKING - INTERIOR ISLANDS

7 7 11 11 11 11	O INTENION I				
Quantit	y Symbol	Scientific Name	Common Name	Planting Size	Planting Remarks
118	*	llex crenata	JAPANESE HOLLY	36" MIN.	8' O.C.
6	0	Quercus virginiana	Southern Live Oak	3"-CAL. MIN.	
3	\otimes	Crecis canadensis	RED BUD	6–8', 3"–CAL.	
4	X X	Betula nigra	RIVER BIRCH	6-8', 3"-CAL.	

PARKING - PERIMETER

1 AMM) I LINIMIL ILI	1			
Quantit	y Symbol	Scientific Name	Common Name	Planting Size	Planting Remarks
31	$\{x\}$	Prunus x 'okame'	FLOWERING CHERRY	6-8', 3"-CAL.	
73	Ø	Abelia grandifolia	GLOSSY ABELIA	15–18" MIN.	4' O.C.

O.C. — "ON CENTER" CAL. — "CALIPER AT 6" ABOVE GRADE" GAL. — "GALLON CONTAINER"




ENGINEERING LAND PLANNING

COMMERCIAL / RESIDENTIAL P.O. Box 4041 Wilmington, NC 28406 (910) 791-4441

TR4 1 FOOD LOCATED NEW HAN



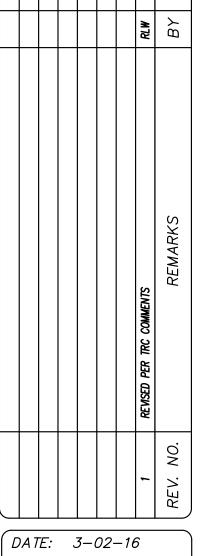

HORZ. SCALE: 1" = 20' VERT. SCALE: N/A

DRAWN BY: JSM CHECKED BY: HSR PROJECT NO.: 07-0152

LANDSCAPE CALCULATIONS:

- PARKING INTERIOR AREA LANDSCAPING (SEC. 18–481): 1 CANOPY TREE AND SHRUBBERY * 6 INTERIOR PARKING ISLANDS
- 6 CANOPY TREES AND SHRUBS REQ'D;
- CANOPY TREES / SHADE TREES PLACED THROUGHOUT PARKING AREA TO AVOID CONFLICT WITH DESIGNED UTILITIES.
- SHADING CALCULATION 20% SHADING REQ'D FOR PARKING AREAS.
- 48,744 PARKING AREA X 20%; 48,744 X .2 = 9749 SF REQ'D CANOPY - SOUTHERN LIVE OAK HAS ESTIMATED 50 FT DIA. CANOPY AT MATURITY; ±1962.5 SF CANOPY
- 9749 / 1962.5 = 4.96 OR 5 CANOPY TREES; 6 CANOPY TREES PROVIDED. - OTHER SELECTED TREES HAVE ESTIMATED 20–25 FT DIA. CANOPY AT MATURITY; ± 490 SF CANOPY 7 CANOPY TREES PROVIDED 7 X 490 = 3,430 SF OF ADDITIONAL SHADING. ((1962.5 X 6) + (490 X 7)) = 15,205 SF OF PROPOSED CANOPY AT MATURITY.
- 15,205 / 48,744 = 0.311 OR 31% PROPOSED CANOPY AY MATURITY.
- . PARKING PERIMETER LANDSCAPING (SEC. 18–482): 1 TREE EVERY 18 TO 27'; 583 LF = 22 TO 32 TREES 22 TO 32 TREES REQ'D; 31 TREES PROVIDED
- . TREES & SHRUBS IN THE SETBACK AREA SHALL BE MAINTAINED BY THE OWNER TO ENSURE THAT THE MATERIAL LIVES & PROSPERS.
- . PARKING AREA SCREENING:
- SHRUBBERY PROVIDE FOR MAXIMUM OPACITY OF VEHICLE HEADLIGHTS.
- 5. SEC. 18–258 (E) CALCULATIONS AS FOLLOWS; TOTAL PROJECT LIMITS = 88,157 SF, TOTAL LANDSCAPED AREA = 11,960 SF 11,960 / 88,157 = 0.1357 OR 14%
- 14% > 6% (MINIMUM LANDSCAPED AREA) -ONE (1) TREE AND SIX SHRUBS REQ'D FOR EVERY FIFTEEN (15) PARKING SPACES. 1 / 15 = 0.0667 TREES PER PARKING SPACE. 6 / 15 = 0.4 SHRUBS PER PARKING SPACE. 132 PARKING SPACES PROVIDED; 132 X 0.0667 = 8.8 TREES REQ'D, 6 SHADE TREES & 30 UNDERSTORY
- 132 X 0.4 = 52.8 SHRUBS REQ'D, <u>154</u> VARIOUS SHRUBS PROVIDED
- 6. TREES & SHRUBS IN LANDSCAPED AREAS SHALL BE MAINTAINED BY THE OWNER TO ENSURE THAT THE MATERIAL LIVES & PROSPERS.
- 7. NO REGULATED OR SIGNIFICANT TREES LOCATED ONSITE.
- 8. TREES WITHIN SIGHT TRIANGLES TO BE SELECTED, TRIMMED, AND MAINTAINED TO MEET SEC. 18–566.

Approved Construction Plan

SCALE IN FEET: 1"= 20'

. TREES WITH ROOTS IN CLOSE PROXIMITY TO UTILITIES SHALL REQUIRE A ROOT BARRIER.